



Know what's **below**. **Call** before you dia

Call before you dig.		
SIT	E INFORMATION	GI
SITE NAME: LOCATION CODE: SITE ADDRESS: COUNTY: LATITUDE: LONGITUDE: GROUND LEVEL: PROPERTY OWNER: PARCEL ID: STRUCTURE TYPE:	E INFORMATION PEMBROKE_5_MA 430514 85 WASHINGTON ROAD PEMBROKE, MA 02359 PLYMOUTH COUNTY 42° 06' 11.79" N (NAD83) 70° 48' 14.99" W (NAD83) 70° 48' 14.99" W (NAD83) 74' A.M.S.L. (NAVD88) CIRCLE PEMBROKE RETAIL 19 CRAIG ROAD ACTON, MA 01720 D14–38 PROPOSED MONOPOLE TOWER	 THIS IS AN 1. THIS IS AN 1.1. HAN 1.2. POT 1.3. NO CONTRACTO SITE. CON DISCREPAN ARCHITECT DISCREPAN DEVELOPM ORDINANCE 3.1 DEVELOPM ORDINANCE 3.1
STRUCTURE HEIGHT: HIGHEST APPURTENANCE: (4' LIGHTNING ROD) VZW TOWER EQUIPMENT C.L.:	120'-0"± A.G.L. 124'-0"± A.G.L.	STANDARDS 3.4 STRU 3.5 CONS 3.6
Course	ITY MAP SCALE: 1"=500'	3.7 3.8 3.9 3.10 TELEC FOR ANY CON MATERIAL, MET REQUIREMENT AND A SPECIF
S	APPROX. NORTH	

CELLCO PARTNERSHIP d/b/a VERIZON WIRELESS 118 FLANDERS ROAD, 3RD FLOOR WESTBOROUGH, MA 01581

SITE NAME:

PEMBROKE 5 MA

LOCATION CODE:

430514

SITE ADDRESS: **85 WASHINGTON ROAD** PEMBROKE, MA 02359

GENERAL NOTES AND APPLICABLE CODES

AN UNMANNED TELECOMMUNICATION FACILITY AND NOT FOR HUMAN HABITATION.

ANDICAPPED ACCESS IS NOT REQUIRED. DTABLE WATER OR SANITARY SERVICE IS NOT REQUIRED. OUTDOOR STORAGE OR ANY SOLID WASTE RECEPTACLES REQUIRED.

TOR SHALL VERIFY ALL PLANS, EXISTING DIMENSIONS, AND CONDITIONS ON THE JOB ONTRACTOR SHALL IMMEDIATELY NOTIFY THE ARCHITECT/ENGINEER IN WRITING OF ANY ANCIES BEFORE PROCEEDING WITH THE WORK. FAILURE TO NOTIFY THE CT/ENGINEER PLACES THE RESPONSIBILITY ON THE CONTRACTOR TO CORRECT THE ANCIES AT THE CONTRACTOR'S EXPENSE.

MENT AND USE OF THE SITE WILL CONFORM TO ALL APPLICABLE CODES, CES AND SPECIFICATIONS.

BUILDING CODE: MASSACHUSETTS STATE BUILDING CODE 780 CMR 9TH EDITION W/ AMENDMENTS TO THE INTERNATIONAL BUILDING CODE (IBC 2015)

ELECTRICAL CODE: NATIONAL ELECTRIC CODE 2017 TRACTOR'S WORK SHALL COMPLY WITH THE LATEST EDITION OF THE FOLLOWING DS.

AMERICAN CONCRETE INSTITUTE (ACI) 318, BUILDING CODE REQUIREMENTS FOR UCTURAL CONCRETE.

AMERICAN INSTITUTE OF STEEL CONSTRUCTION (AISC), MANUAL OF STEEL **NSTRUCTION**.

TELECOMMUNICATIONS INDUSTRY ASSOCIATION (TIA)

3.6.1 TIA 222-G, STRUCTURAL STANDARDS FOR STEEL ANTENNA SUPPORTING STRUCTURES AND ANTENNAS WITH ADDENDUM. 3.6.2 TIA 607, GENERIC TELECOMMUNICATIONS BONDING AND GROUNDING

(EARTHING) FOR CUSTOMER PREMISES. INSTITUTE FOR ELECTRICAL AND ELECTRONICS ENGINEERS (IEEE)

3.7.1 IEEE 81, GUIDE FOR MEASURING EARTH RESISTIVITY, GROUND IMPEDANCE, AND EARTH SURFACE POTENTIALS OF A GROUNDING SYSTEM. 3.7.2 IEEE 1100 (2005) RECOMMENDED PRACTICE FOR POWERING AND

GROUNDING OF ELECTRONIC EQUIPMENT.

3.7.3 IEEE C62.41.1, RECOMMENDED PRACTICES ON CHARACTERIZATION OF SURGES IN LOW VOLTAGE (1000V OR LESS) AC POWER CIRCUITS.

TELCORDIA, GR-1275, GENERAL INSTALLATION REQUIREMENTS. TELCORDIA, GR-1503, COAXIAL CONNECTORS.

0 ANSI T1.311, TELECOMMUNICATIONS - DC POWER SYSTEMS -

ECOMMUNICATIONS ENVIRONMENT PROTECTION.

ONFLICTS BETWEEN SECTIONS OF LISTED CODES AND STANDARDS REGARDING ETHODS OF CONSTRUCTION, OR OTHER REQUIREMENTS, THE MOST RESTRICTIVE SHALL GOVERN. WHERE THERE IS CONFLICT BETWEEN A GENERAL REQUIREMENT CIFIC REQUIREMENT, THE SPECIFIC REQUIREMENT SHALL GOVERN.

T-1TITLE SHEET C-1 ABUTTERS PLAN & OVERALL SITE PLAN Z-1 ENLARGED SITE & Z-2 TOWER ELEVATION Z-3 DETAILS Z-4 SOIL EROSION & SE ES-1 ES-2 SOIL EROSION & SE

SHEET NUMBER


THE FOLLOWING PARTIES HEREBY APPR THE CONTRACTOR TO PROCEED WITH T DOCUMENTS ARE SUBJECT TO REVIEW IMPOSE CHANGES OR MODIFICATIONS.

LEASING/SITE ACQUISITION: _____

LANDLORD: _____

VZW CM: _____

		DDE	EPARED BY:		
	LONING		EPARED BY:		
			16	XIU	5
	DRAWINGS			A&E OFFICE: LO DRIVE , 2ND FLC	OR
				MSFORD, MA 01824	
			PLICANT:		
			ve	rizor	\
			CELI	_CO PARTERSHIP	
		1	d/b/a 118 FLANDI	VERIZON WIRELES ERS ROAD, 3RD I DROUGH, MA 0158	FLOOR
				JILIN OF MISS	
				CIVIL No. 54631	
SHEET INDEX			•	THE STUDY ST	
SHEET DESCRIPTION				Digitally signed by Jordan DN: C=US,	n D Phillips PE
TITLE SHEET			Jordan D Phil	Lips PE E=jordan.phillips@nexius O="Nexius Solutions, Inc. Group - Strucural Enginee CN=Jordan D Phillips PE Location: Sylvan Lake, M Reason: I am the author of document	", OU=A/E ering, I of this
ABUTTERS PLAN & EXISTING CONDITIONS				Contact Info: (248) 709-30 Date: 2021.01.08 16:40:0	642 8-05'00'
OVERALL SITE PLAN					
ENLARGED SITE & GRADING PLAN		COPY	RIGHT OF NEX BY THE TITLE (HOUT THE EXF	IS THE DESIGN PROPE (IUS AND FOR THE EXC CLIENT. DUPLICATION PRESS WRITTEN CONSEN IS STRICTLY PROHIBITE	CLUSIVE USE OR USE NT OF THE
TOWER ELEVATION & DETAILS			NTED MEDIA O	ARE INTENDED FOR 24 NLY. ALL OTHER PRIN EMED "NOT TO SCALE"	ITED SIZES
DETAILS			1	SUBMITTALS	
SOIL EROSION & SEDIMENTATION CONTRO	DL PLAN & NOTES	- REV	DATE 03/19/20	DESCRIPTION PRELIMINARY ZONING DRAWINGS	BY MLB
		_ 1	10/20/20	REVISED ZONING	JM
SOIL EROSION & SEDIMENTATION CONTRO	DL DETAILS & NOTES	2	11/10/20 01/08/21	REVISED ZONING	JM JM
		SIT	E INFO:		
			PE	SITE NAME: MBROKE_5_MA	
APPROVALS		1	LC	OCATION CODE:	
ARTIES HEREBY APPROVE AND ACCEPT THE	ESE DOCUMENTS AND AUTHORIZE		S	430514 ITE ADDRESS:	
TO PROCEED WITH THE CONSTRUCTION DE UBJECT TO REVIEW BY THE LOCAL BUILDI OR MODIFICATIONS.	SCRIBED HEREIN. ALL		85 W PEMB	ASHINGTON ROAD ROKE, MA 02359 MOUTH COUNTY	
UISITION:	DATE:	SHE	EET TITLE:		
NDLORD:	DATE:		TITLE SHEET		
VZW CM:	DATE:	NE	NEXIUS PROJ. NO: SHEET NUMBER:		
VZW RF:	DATE:		VZ11509		
		CHI	ECKED BY: JP	T-	-1
		CHI	ECKED BY D 10/20/20		

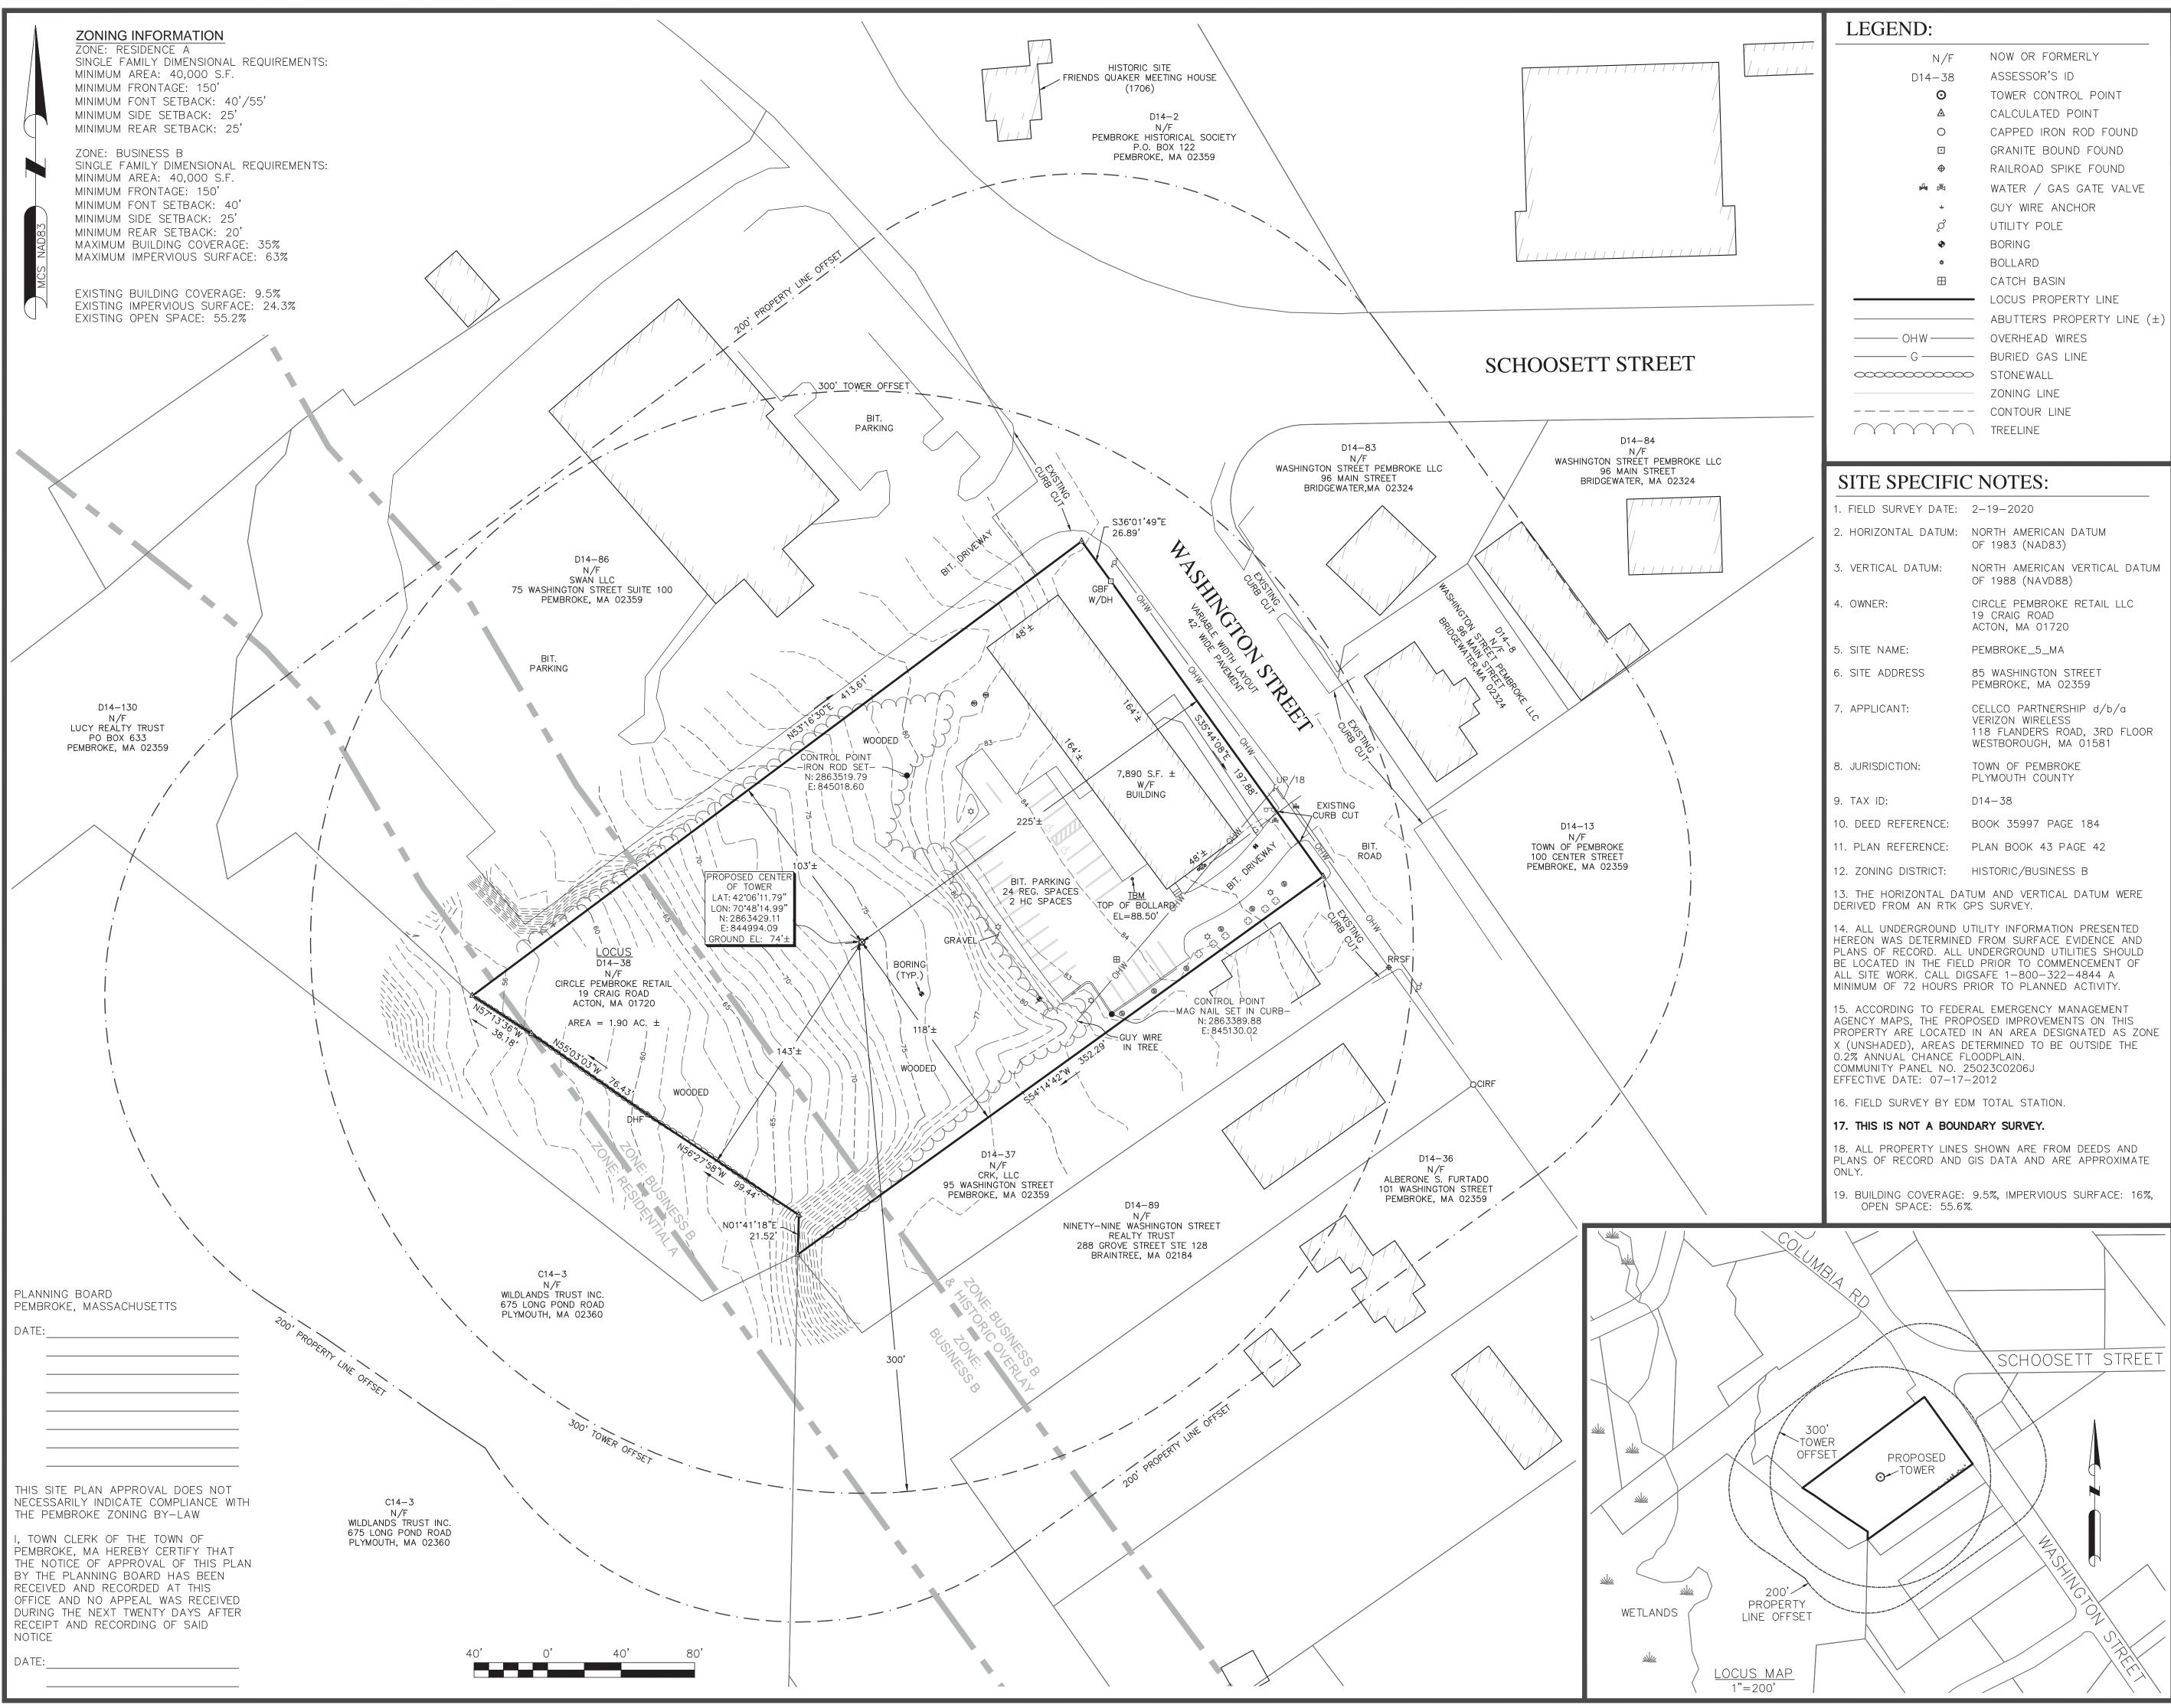

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1. FIELD SURVEY DATE:	2-19-2020
2. HORIZONTAL DATUM:	NORTH AMERICAN DATUM OF 1983 (NAD83)
3. VERTICAL DATUM:	NORTH AMERICAN VERTICAL DATUM OF 1988 (NAVD88)
4. OWNER:	CIRCLE PEMBROKE RETAIL LLC 19 CRAIG ROAD ACTON, MA 01720
5. SITE NAME:	PEMBROKE_5_MA
6. SITE ADDRESS	85 WASHINGTON STREET PEMBROKE, MA 02359
7. APPLICANT:	CELLCO PARTNERSHIP d/b/a VERIZON WIRELESS 118 FLANDERS ROAD, 3RD FLOOR WESTBOROUGH, MA 01581
8. JURISDICTION:	TOWN OF PEMBROKE Plymouth county
9. TAX ID:	D14-38
10. DEED REFERENCE:	BOOK 35997 PAGE 184
11. PLAN REFERENCE:	PLAN BOOK 43 PAGE 42
12. ZONING DISTRICT:	HISTORIC/BUSINESS B
13. THE HORIZONTAL DA DERIVED FROM AN RTK (TUM AND VERTICAL DATUM WERE GPS SURVEY.
HEREON WAS DETERMINE PLANS OF RECORD. ALL BE LOCATED IN THE FIEL ALL SITE WORK. CALL DI	UTILITY INFORMATION PRESENTED D FROM SURFACE EVIDENCE AND UNDERGROUND UTILITIES SHOULD D PRIOR TO COMMENCEMENT OF IGSAFE 1-800-322-4844 A PRIOR TO PLANNED ACTIVITY.
AGENCY MAPS, THE PRO PROPERTY ARE LOCATED	25023C0206J
16. FIELD SURVEY BY ED	DM TOTAL STATION.
17. THIS IS NOT A BOUN	IDARY SURVEY.
	S SHOWN ARE FROM DEEDS AND GIS DATA AND ARE APPROXIMATE
19. BUILDING COVERAGE: OPEN SPACE: 55.62	9.5%, IMPERVIOUS SURFACE: 16%, %.
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PREPARED BY:

nexius TRANFORM YOUR BUSINESS...THROUGH WIRELESS

> A&E OFFICE: 300 APOLLO DRIVE, SUITE 7 CHELMSFORD, MA 01824 1 (978) 923-7965


APPLICANT:



CELLCO PARTNERSHIP d/b/a VERIZON WIRELESS 118 FLANDERS ROAD, 3RD FLOOR WESTBOROUGH, MA 01581

I HEREBY CERTIFY TO THE BEST OF MY PROFESSIONAL KNOWLEDGE, INFORMATION AND BELIEF THAT:

THIS SURVEY HAS BEEN PERFORMED IN THE FIELD UNDER MY SUPERVISION, AND TO MY KNOWLEDGE, BELIEF AND INFORMATION, THIS SURVEY HAS BEEN PERFORMED IN ACCORDANCE WITH CURRENTLY ACCEPTED ACCURACY STANDARDS;

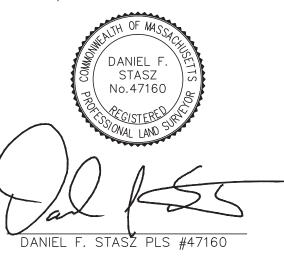

SUBMITTALS									
REV	DATE	DESCRIPTION	BY						
1	02/24/2020	SUBMITTED FOR REVIEW	JDG						
2	10/5/2020	site plan req's	JDG						
3	1/8/2021	site plan req's	JDG						

SITE INFO:

SITE NAME: PEMBROKE_5_MA LOCATION CODE:

SITE ADDRESS: **85 WASHINGTON STREET** PEMBROKE, MA 02359

SHEET TITLE:

ABUTTERS PLAN & **EXISTING CONDITIONS**


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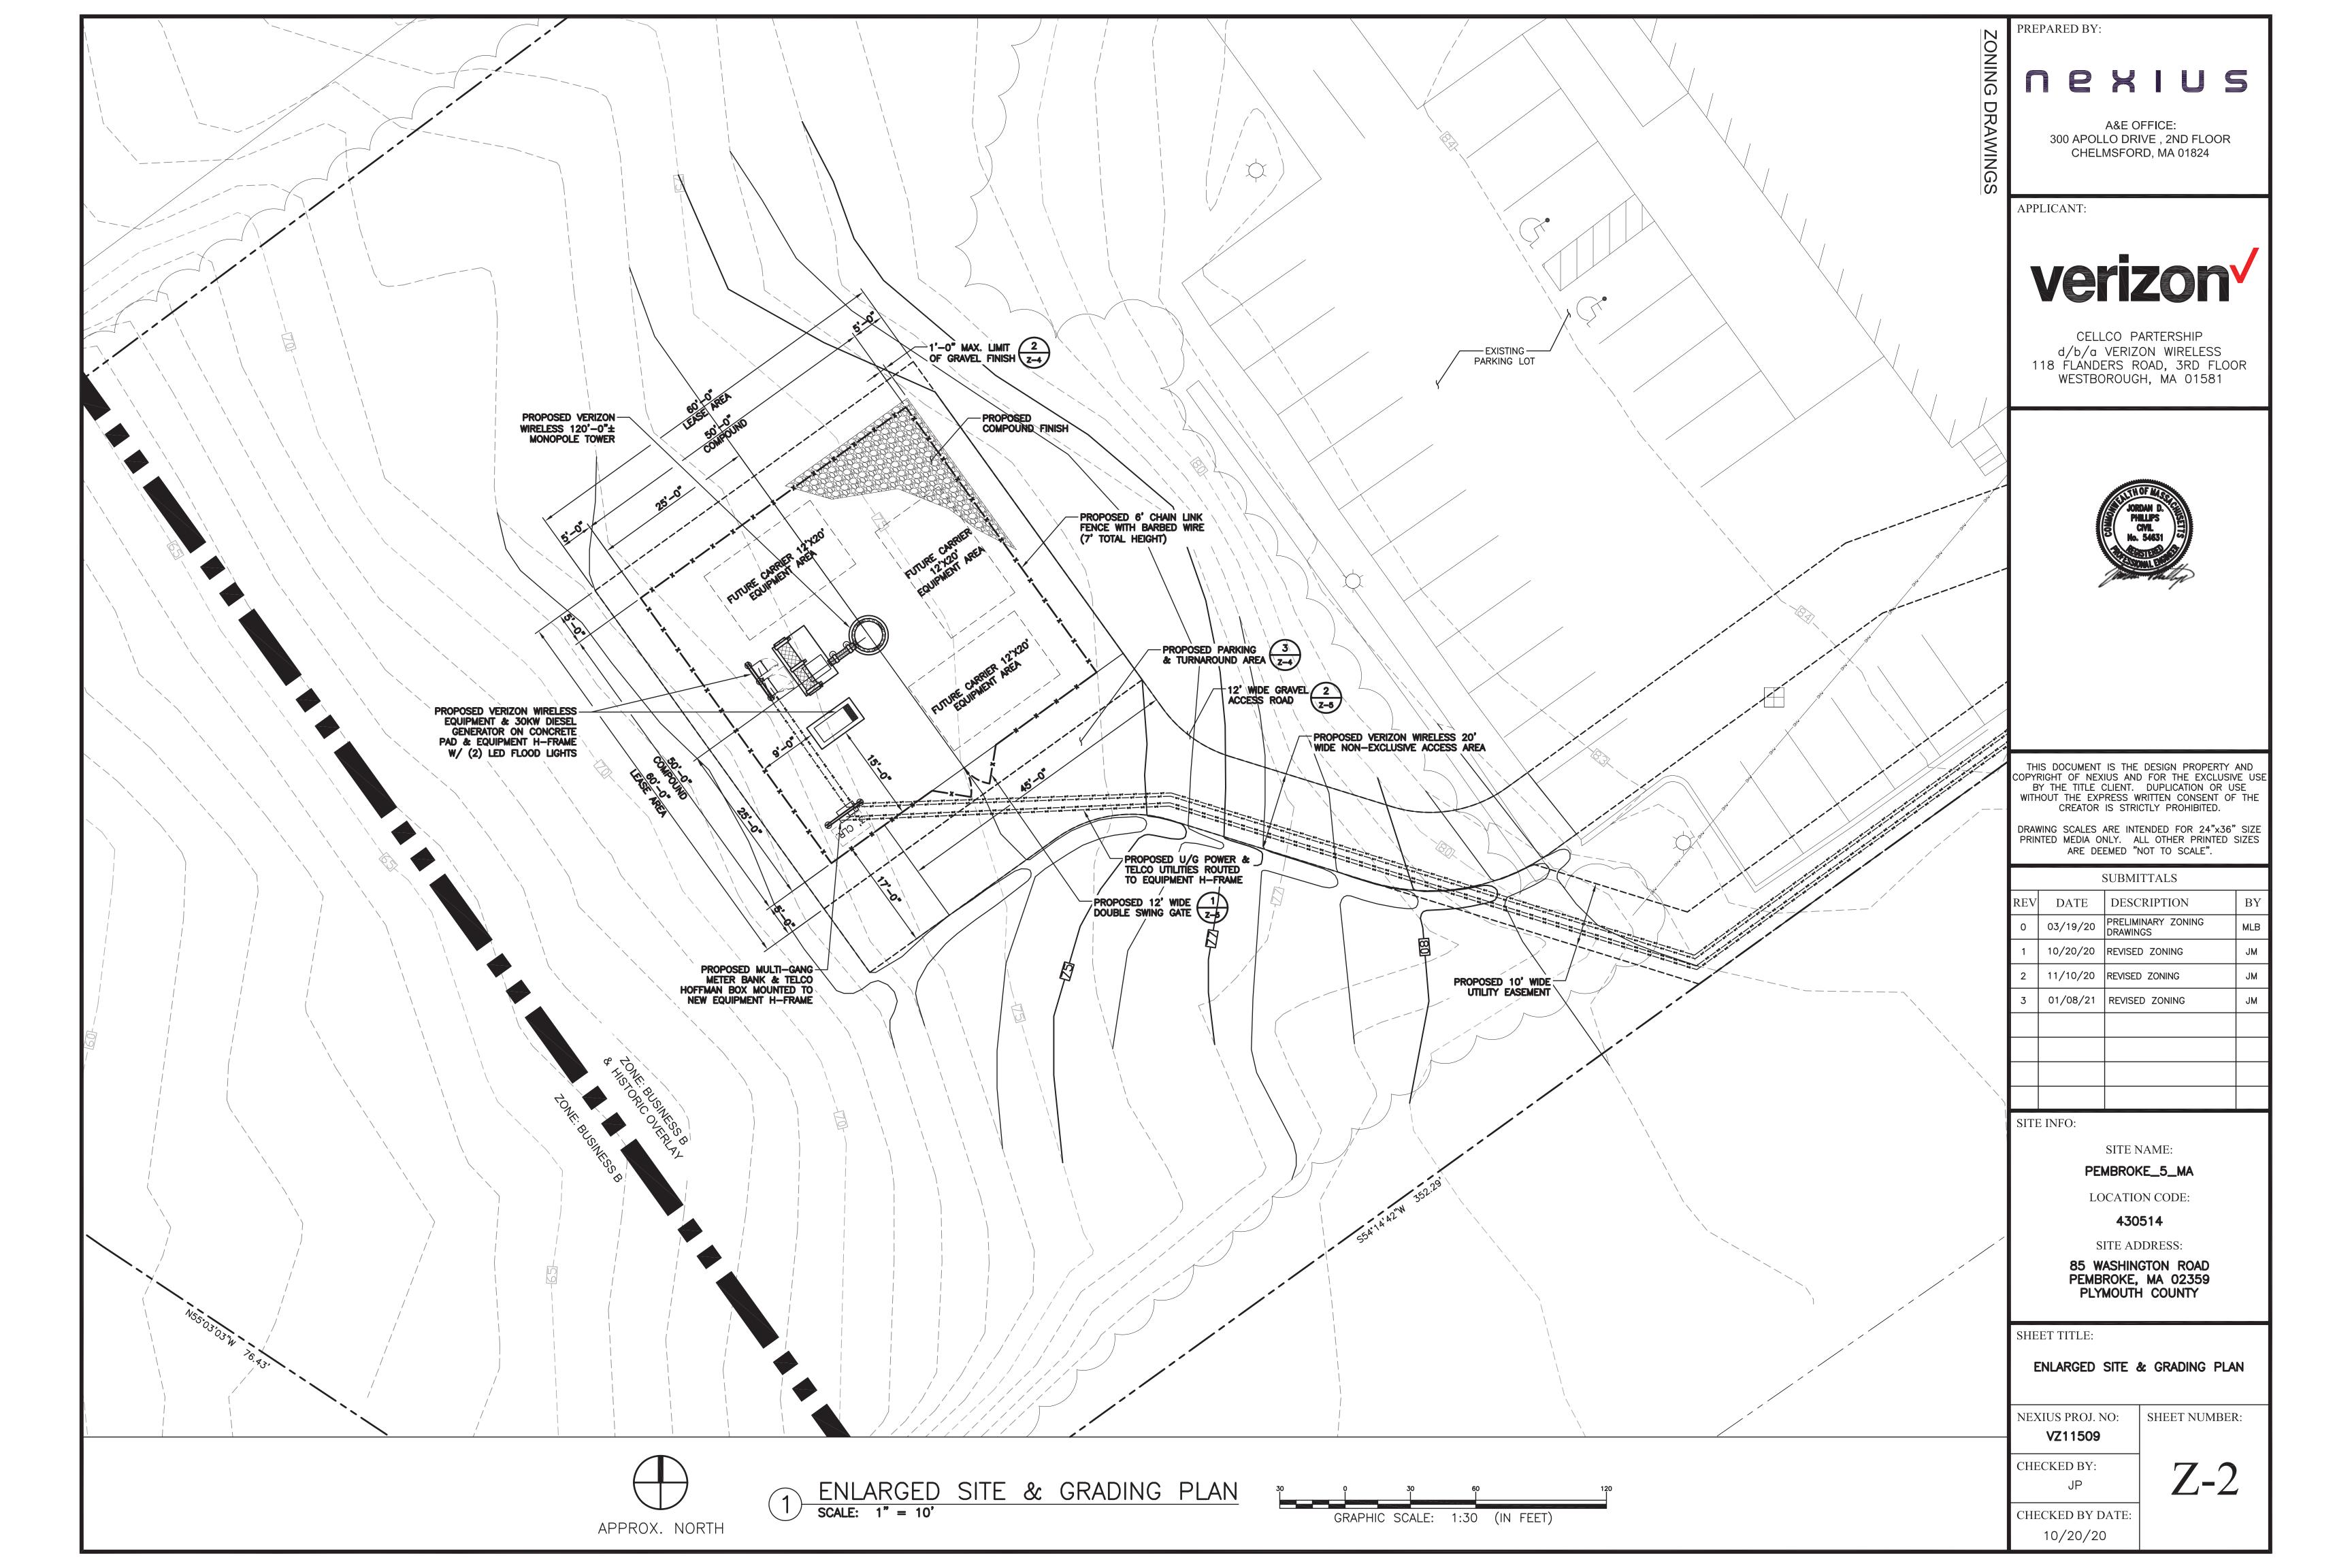
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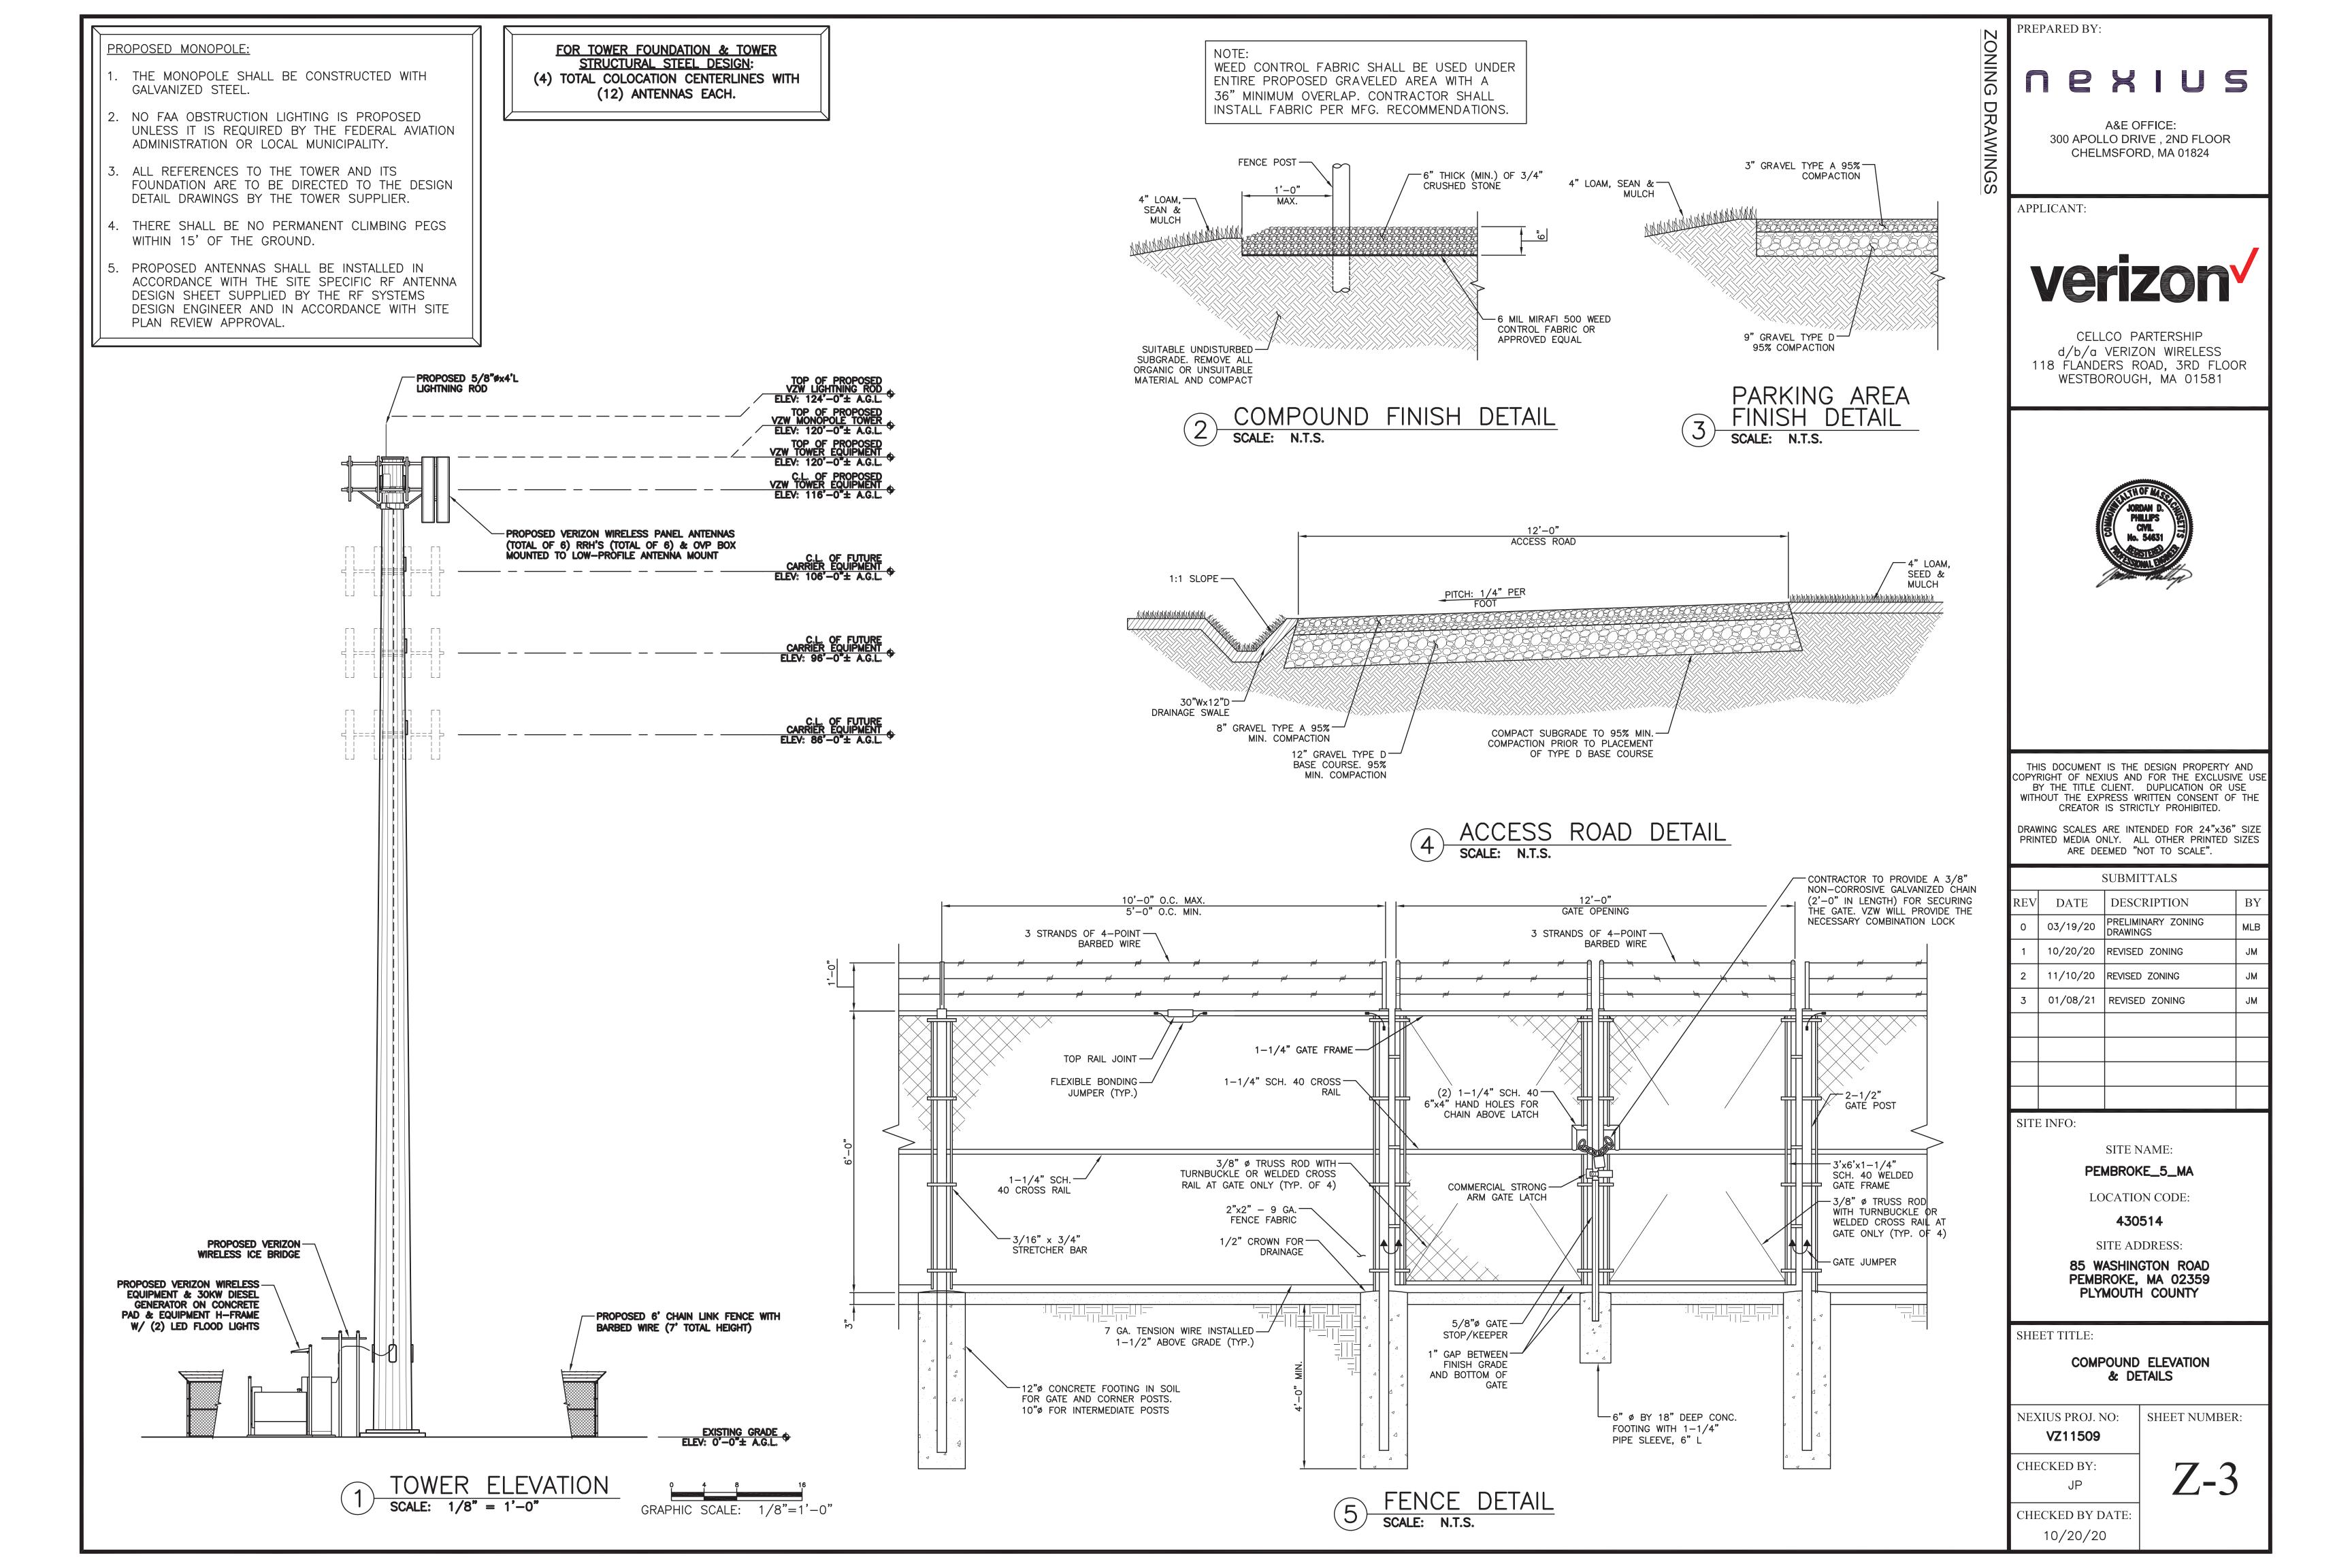
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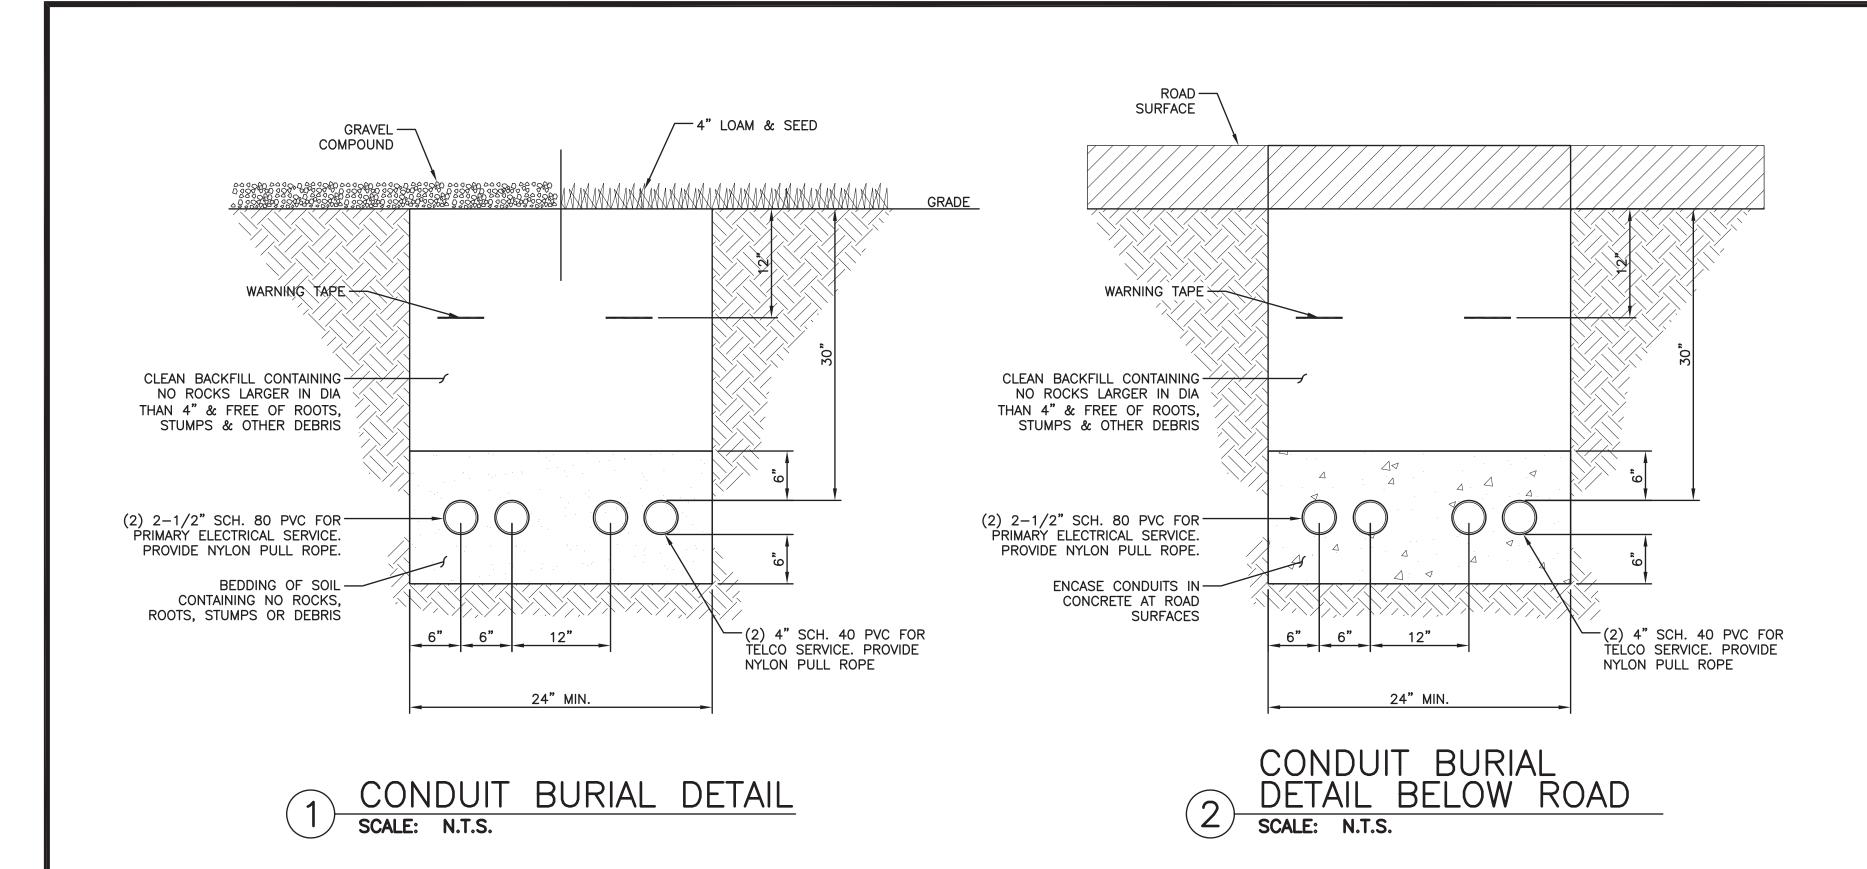
CHECKED BY: BCF


CHECKED BY DATE: 1/8/2021








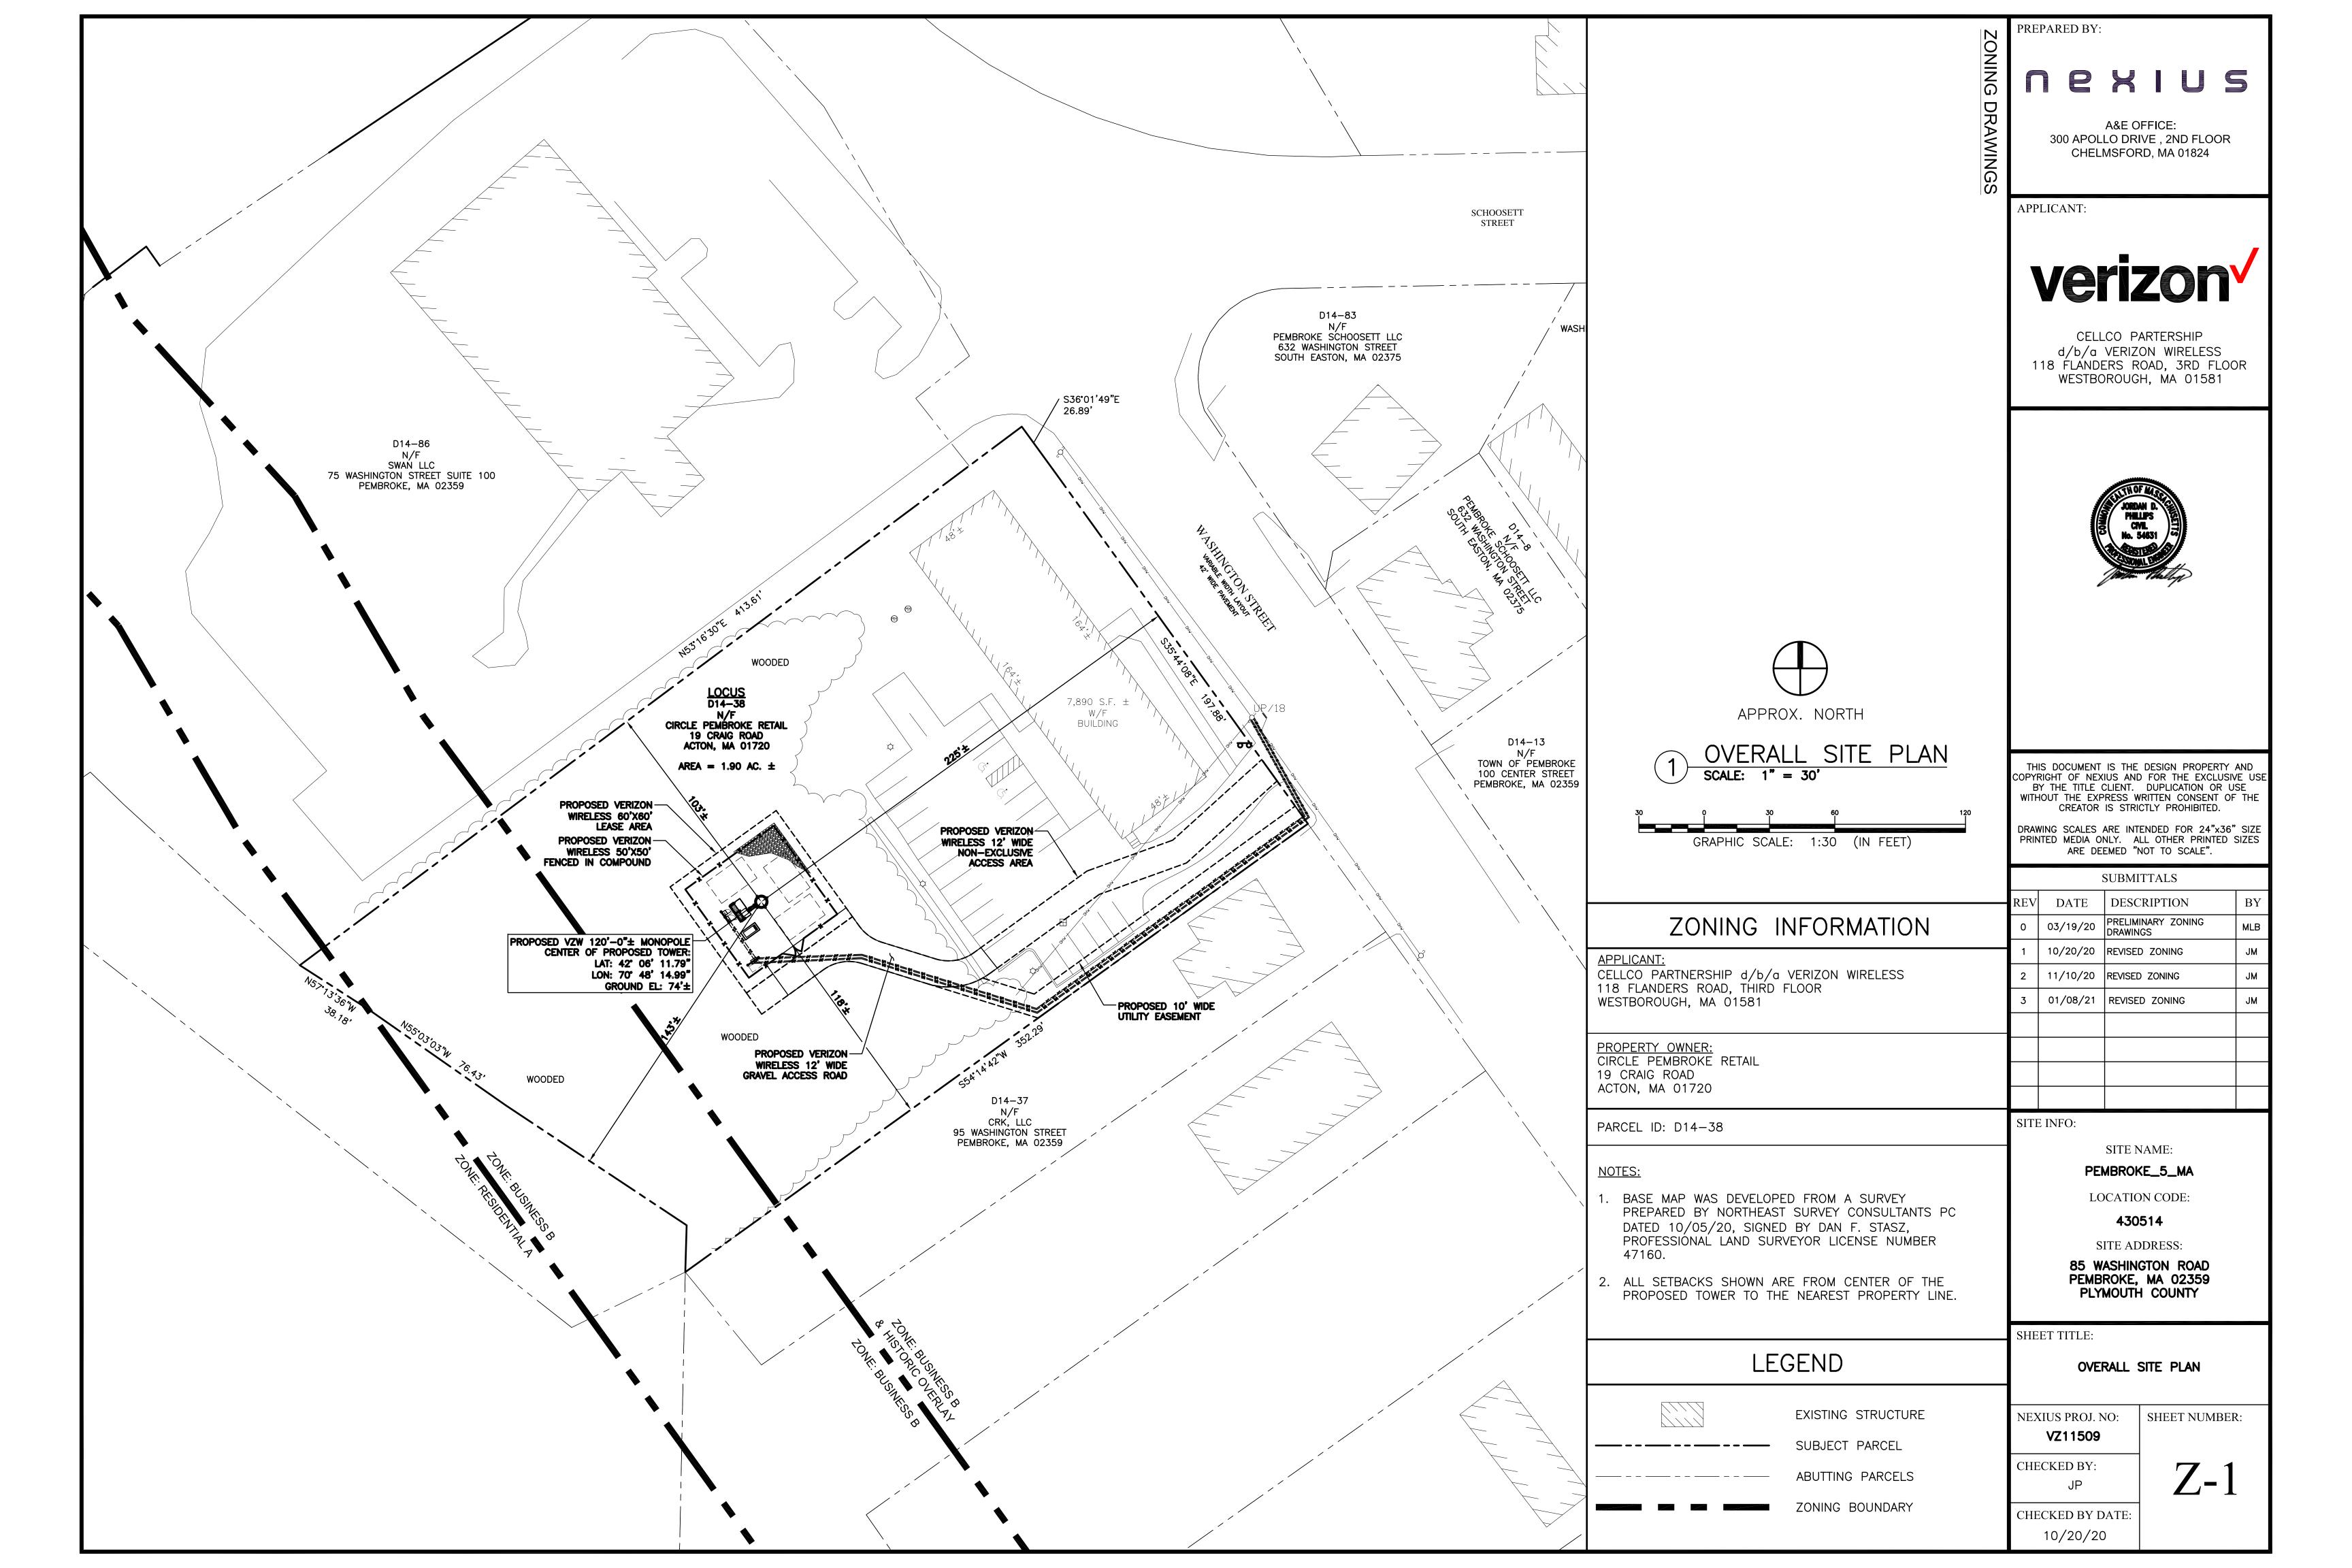


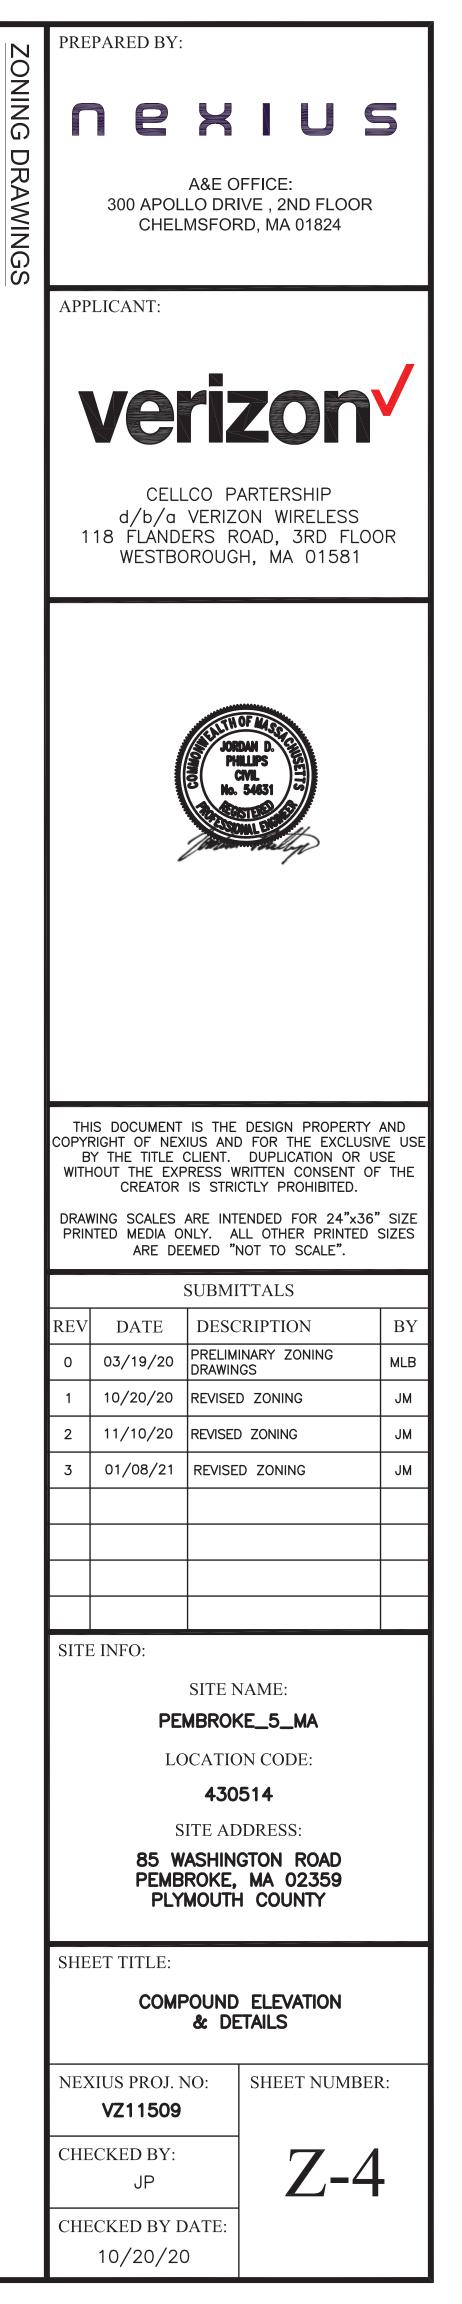

TEMPORARY MULCHING: APPLY HAY OR STRAW GROUND SURFACE. SECURE MULCH BY TRACKING

- BE INSTALLED PRIOR TO ANY MAJOR SOIL MAINTAINED UNTIL PERMANENT PROTECTION IS ESTABLISHED.
- FILTER FABRIC.
- CHECK DAMS IN SWALES AS CONSTRUCTION PROGRESSES CONSTRUCT ACCESS ROAD.
- CONDUIT AND IMMEDIATELY BACKFILL TRENCH.
- FOUNDATIONS WITH EXCAVATED MATERIALS STOCKPILED FOR FUTURE FINAL GRADING. ERECT TOWER AND EQUIPMENT SHELTER. ESTABLISH
- AND MULCH AREA.
- CONTROLS REMAINING AFTER 70% UNIFORM VEGETATIVE COVER STABILIZATION IS ACHIEVED. AREAS DISTURBED DURING REMOVAL OF THE CONTROLS MUST BE STABILIZED IMMEDIATELY.

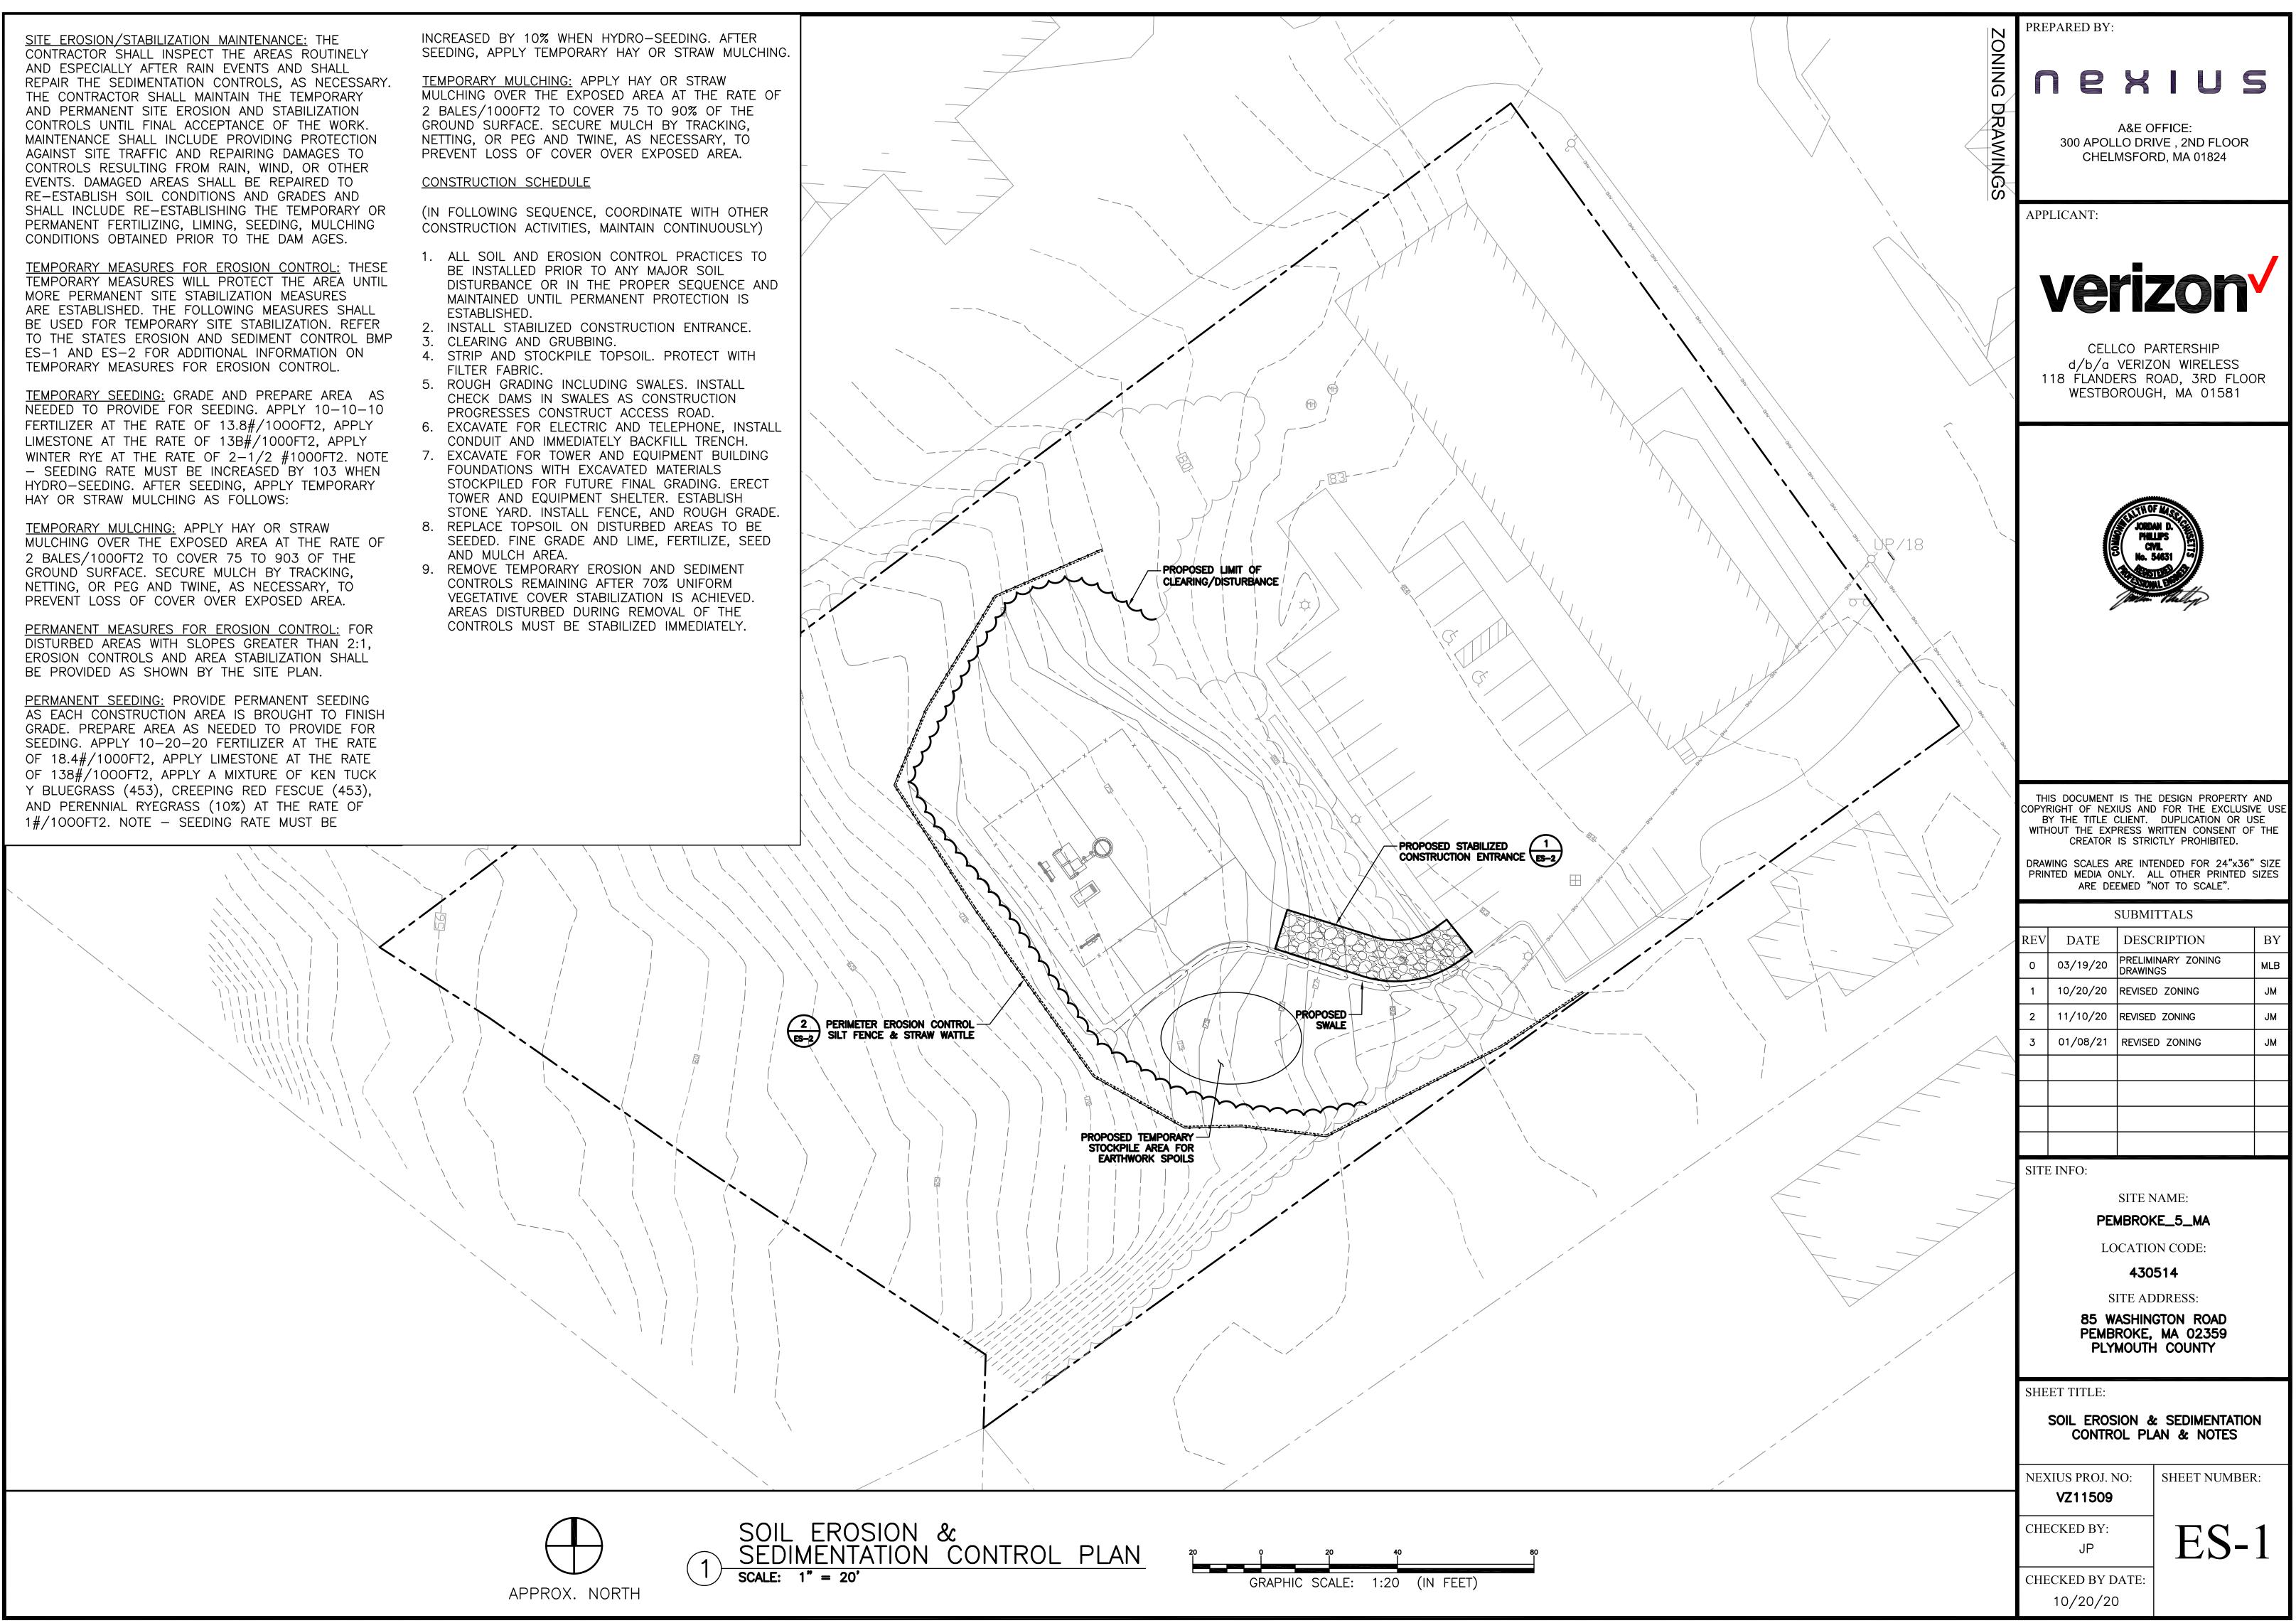

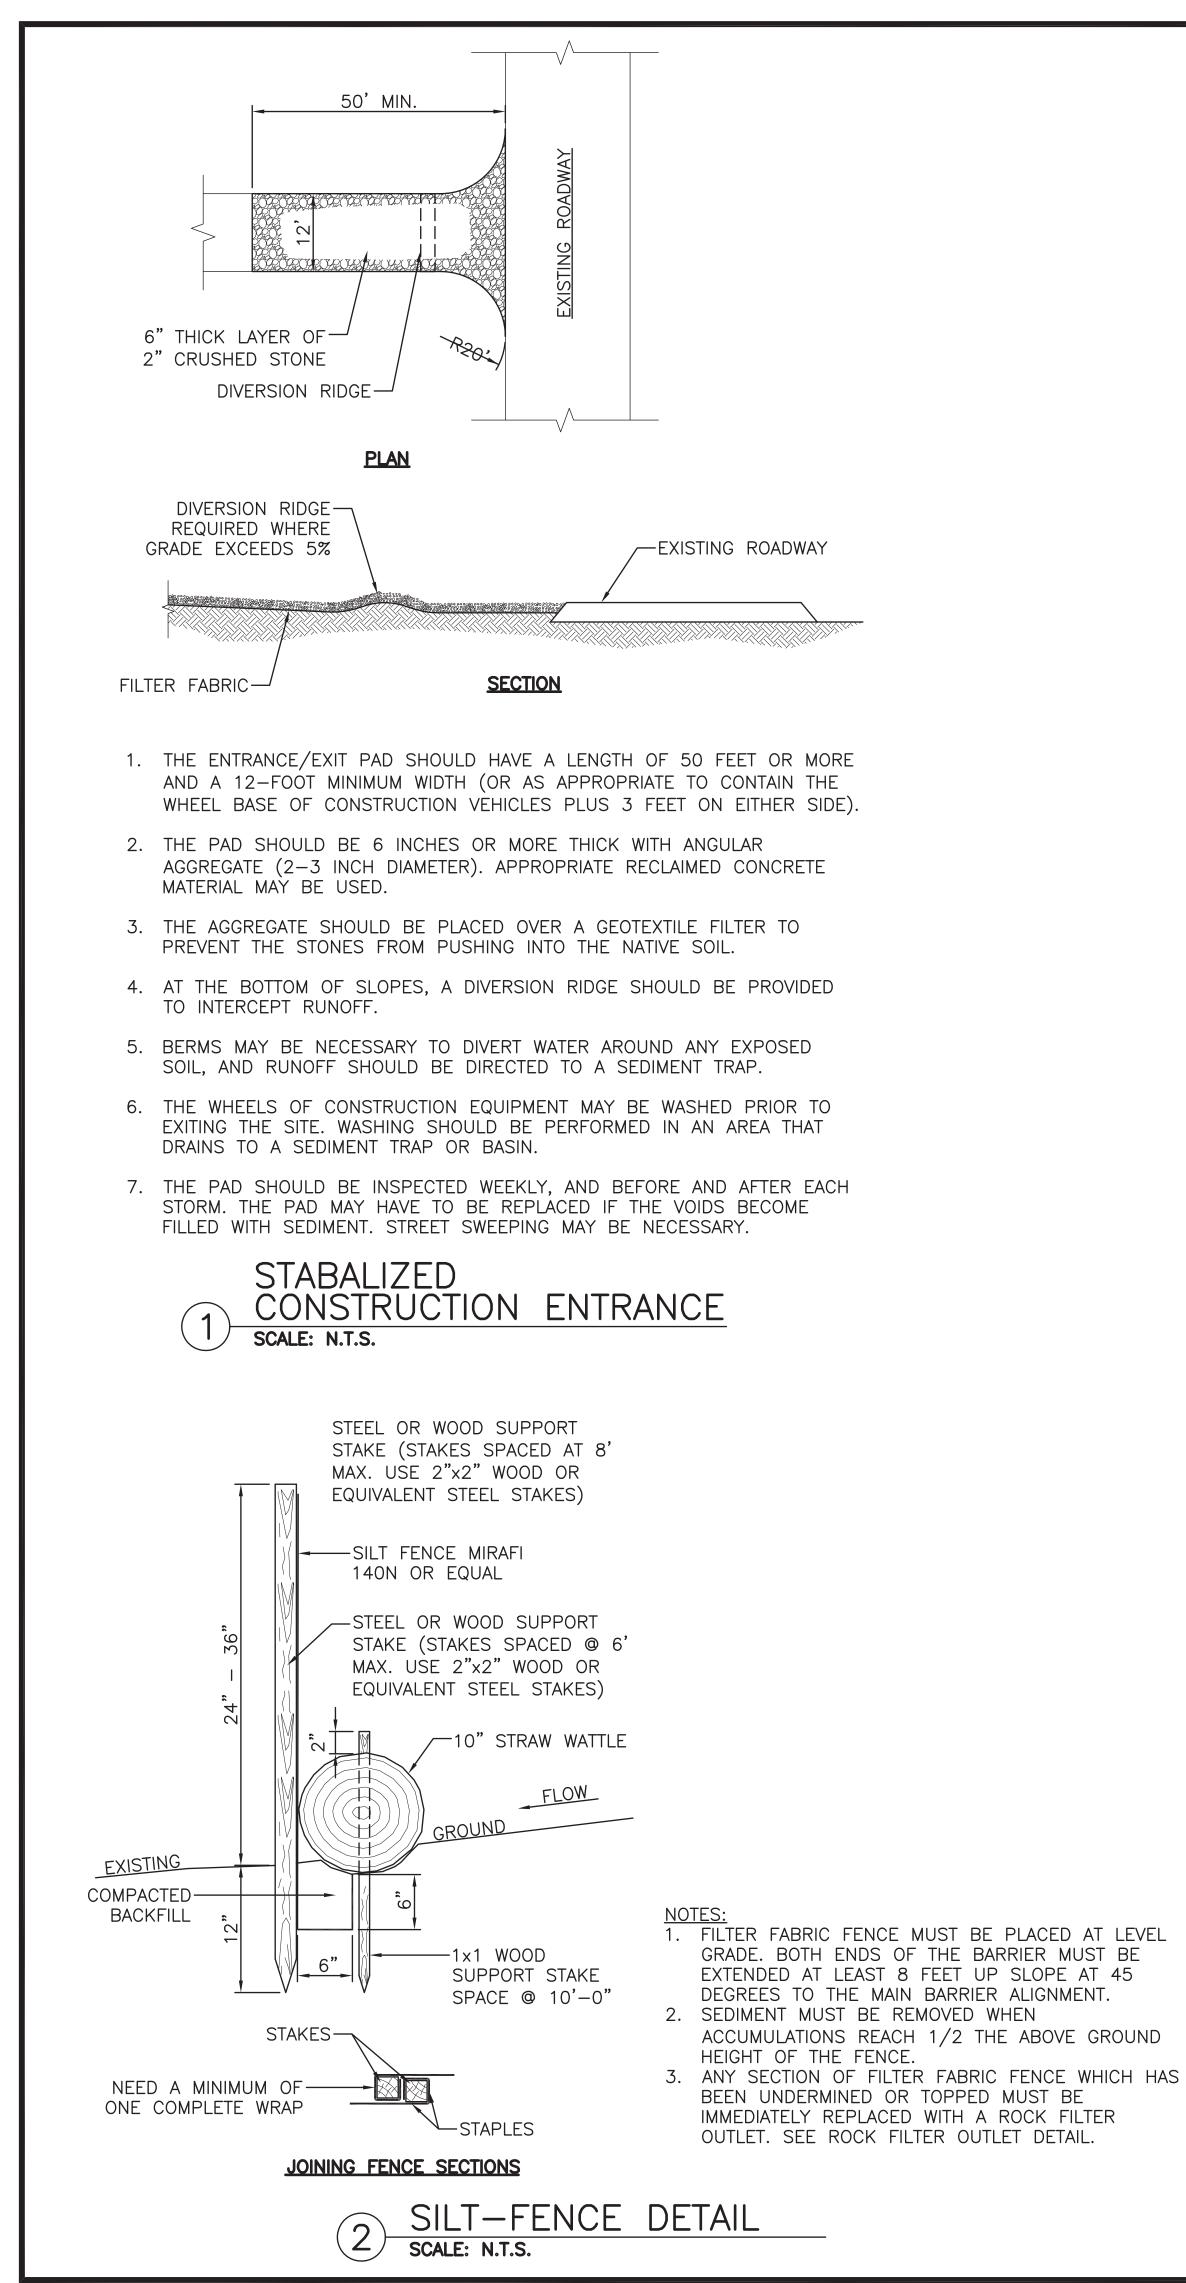

NOTES:

TO PROTECT CONSTRUCTION SITE AREAS AND ADJACENT SENSITIVE LAND AND WATERS OF THE STATE, THE FOLLOWING EROSION AND SEDIMENTATION CONTROLS SHALL BE INSTALLED AND MAINTAINED. THESE MEASURES HAVE BEEN ESTABLISHED TO CONFORM TO STATE OF MAINE EROSION AND SEDIMENT CONTROL "BEST MANAGEMENT PRACTICES (BMP)".

THIS EROSION/STABILIZATION PLAN IS A MINIMUM THAT THE CONTRACTOR MUST DO. GIVEN SITE AND WEATHER CONDITIONS, ADDITIONAL MEASURES MAYBE NEEDED.

SOIL DISTURBANCE: THE CONTRACTOR SHALL LIMIT THE EXTENT OF SOIL EXPOSED DURING CONSTRUCTION TO THE MINIMUM POSSIBLE. EXPOSED AREAS SHALL BE TEMPORARILY OR PERMANENTLY STABILIZED AS SOON AS POSSIBLE BUT NO LATER THAN 15 DAYS AFTER INITIAL DISTURBANCE OF THE SOIL AND WITHIN 7 DAYS OF FINAL GRADING.

ROAD DITCHES; INLET AND OUTLET PROTECTION FOR CULVERTS: EXPOSED AREAS FOR ROAD DITCHING SHALL BE TEMPORARILY OR PERMANENTLY STABILIZED AS SOON AS POSSIBLE BUT NO LATER THAN 7 DAYS AFTER INITIAL DISTURBANCE OF THE SOIL. INLET AND OUTLET PROTECTION FOR CULVERTS SHALL BE TEMPORARILY OR PERMANENTLY STABILIZED AS SOON AS POSSIBLE BUT NO LATER THAN 24 HOURS OF INSTALLING EACH CULVERT, FIELD INLET OR STORM DRAIN OUTFALL.

SILT FENCING AND/OR HAY BALES: INSTALL SILT FENCES AND/OR HAY BALES AROUND SITE EXPOSED AREAS AS SHOWN ON THE SITE PLAN AND FOR ANY ADDITIONAL AREAS DETERMINED TO BE SUBJECT TO SEDIMENT EROSION AS A RESULT OF SITE CONDITIONS. SILT FENCING AND/OR HAY BALES WILL REMAIN IN PLACE UNTIL EXPOSED AREAS HAVE ACQUIRED STABILIZATION. INSTALL THE SILT FENCING AND.OR HAY BALES IN ACCORDANCE WITH DETAILS PROVIDED BY THE SITE PLAN.

STOCK PILING, HAUL ROADS, BORROW AREAS: THE CONTRACTOR SHALL VERIFY THAT STOCKPILING, HAUL ROAD, AND BORROW AREAS SHALL NOT BE LOCATED IN WETLANDS AND AREAS OF CONCENTRATED FLOWS. SILT FENCES, MULCHING, AND OTHER EROSION CONTROL MEASURES SHALL BE PROVIDED TO PROVIDE SEDIMENTATION CONTROL TO THESE AREAS.

DUST CONTROL: THE EXPOSED SOIL SURFACE SHALL BE MOISTENED PERIODICALLY WITH ADEQUATE WATER TO CONTROL DUST.

